


South East Elevation Scale 1:200

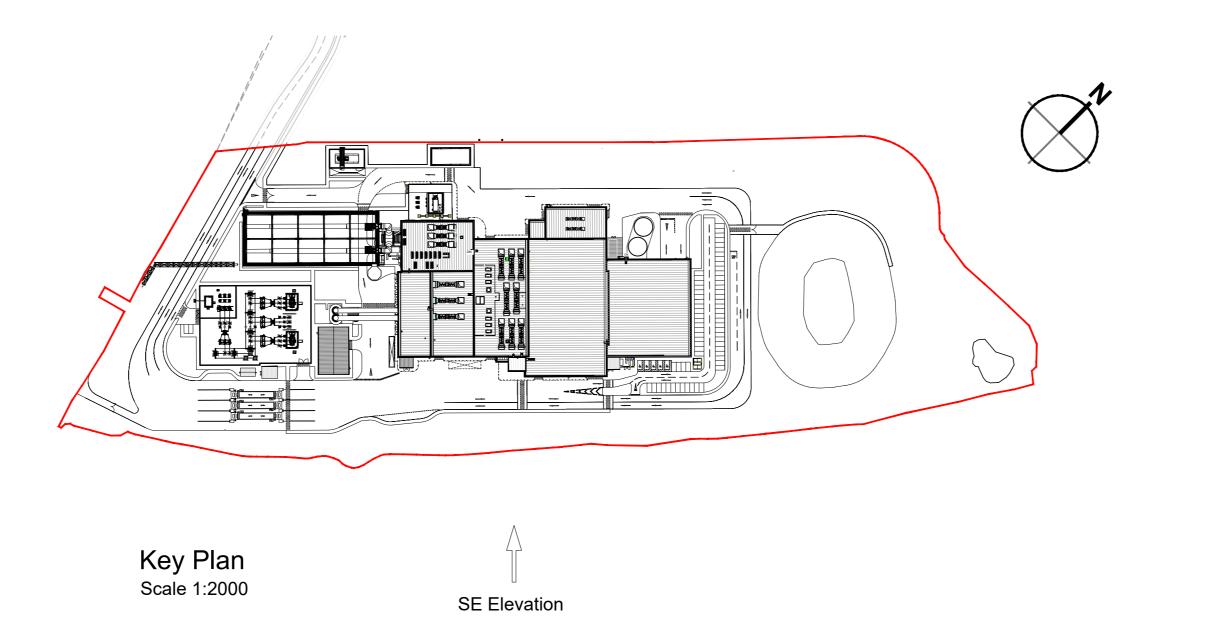

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- 1. If this drawing has been received electronically it is the recipients responsibility to print the document to the correct scale.
- 2. All dimensions are in millimetres unless stated otherwise. It is recommended that information is not scaled off this drawing.
- 3. This drawing should be read in conjunction with all other relevant drawings and specifications.

- A. Horizontally laid Sinusoidal profile insulated built-up cladding with Colorcoat HPS200® Ultra coating - Colour 'Terracotta' (matt finish) / RAL 040 40 40
- B. Horizontally laid microrib profile insulated cladding panel with Colorcoat HPS200® Ultra coating - Colour 'Albatross' / RAL
- 240 80 05
- C. Horizontally laid microrib profile insulated cladding panel with Colorcoat HPS200® Ultra coating, 1000mm deep bands -Colours random mixture 'Terracotta (matt finish) RAL 040 40 40/ Merlin Grey RAL 180 40 05/ Anthracite (matt finish) RAL
- D. Vertically laid Trapezoidal profile insulated cladding panel with Colorcoat HPS200® Ultra coating - Colour 'Anthracite' (matt
- finish) / RAL 7016 E. Stack - Colour `Light Grey` / RAL 7035

7016/ Hamlet RAL 9002

- F. Horizontally laid microrib profile cladding sheet with Colorcoat HPS200® Ultra coating, 1000mm deep bands - Colours random mixture 'Terracotta (matt finish) RAL 040 40 40/ Merlin Grey RAL 180 40 05/ Anthracite (matt finish) RAL
- 7016/ Hamlet RAL 9002 G. Horizontally laid microrib profile insulated cladding panel with Colorcoat HPS200® Ultra coating - Colour 'Terracotta' (matt
- finish) / RAL 180 40 05 H. Aluminium Louvres to be PPC colour Merlin Grey RAL 180 40

05 / Anthracite (matt finish) RAL 7016

All **Doors** and **Louvres**- colour and dimensions to be

Polyester powder coated aluminium window frames -

Colour 'Anthracite' (matt finish) / RAL 7016 Metal external handrails and plant support - Galvanised

Paladin fencing and gates - Colour 'Anthracite' (matt finish) /

Drawing for PLANNING purposes only

Content of drawing based on UMC drawing number 502520020002\_UMG0290and CNIM drawing AAK-04-0202\_64G0008.

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K Elevation and site plan updated BC TFH 17.09.2018 PBR TFH 20.06.18 J Elevation updated to reflect recent client Admin HVAC area updated. Escape stairs updated to be un-enclosed stair. Key Plan updated. G Client logos updated. Steam export rack updated as per CNIM drawing. Walkway enclosure added. CEMS Building added. Escape stair added. Key updated. JH CMGD 20.01.17 Dimensions added JH CMGD10.01.17 Elevation and Site Plan updated. D Elevations Updated to suit latest UI design. Keyplan updated to show revised site plan. Cladding design clarified. C Elevations updated. JAT SG 09.10.12 KRy PRP 15.02.10 B E.ON logo added.
Building extents confirmed. A Crane area material changed.
Keyplan outline clarified. AJL PRP 18.01.10 T +44 (0) 1636 605 700 F +44 (0) 1636 610 696 Sherwood House Sherwood Avenue W www.rpsgroup.com
E rpsnewark@rpsgroup.com Newark, Nottinghamshire Wheelabrator Project Kemsley Sustainable Energy Plant ■ Title Main Building
Proposed South East Elevation Drawing Scale Preliminary 23.11.09 1:200 Initial Review Drawing Number

16315 / A0 / P / 0125 K

FIGURE 4.8D